POTOMAC TOWERS - ROOF REPLACEMENT


LOCATED AT:

11 W BALTIMORE ST. HAGERSTOWN, MD 21740

ISSUED ON:

May 29, 2019

SYMBOLS

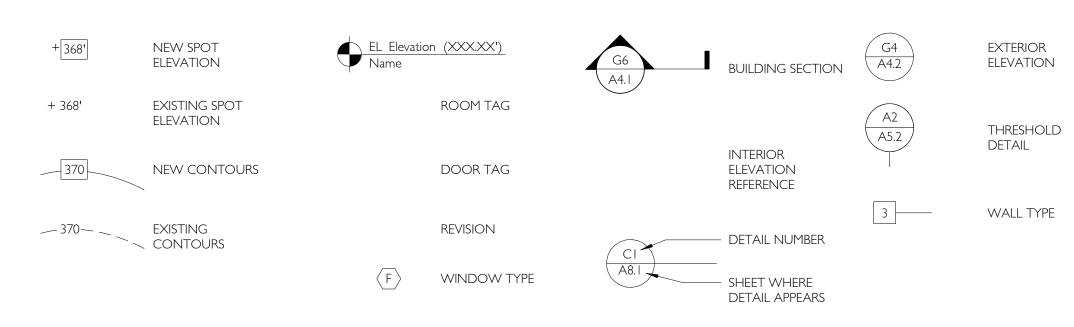

GENERAL CODES


- I. DO NOT SCALE DRAWINGS. WRITTEN DIMENSIONS ON DRAWINGS SHALL GOVERN. CONTRACTOR SHALL VERIFY AND BE RESPONSIBLE FOR ALL DIMENSIONS AND CONDITIONS AND SHALL NOTIFY THIS OFFICE OF ANY VARIATIONS FROM THE DIMENSIONS AND CONDITIONS SHOWN ON THESE DRAWINGS.
- 2. WHERE THERE IS A CONFLICT BETWEEN DRAWINGS, SPECIFICATIONS OR DETAILS, THE CONTRACTOR SHALL CONTACT THE ARCHITECT FOR CLARIFICATION. PRIOR TO CONSTRUCTION, IF CONTRACTOR PROCEEDS WITHOUT NOTIFICATION, THE COST OF MODIFICATION SHALL BE THE RESPONSIBILITY OF THE CONTRACTOR.
- ALL WORK ON THIS PROJECT SHALL COMPLY WITH THE FOLLOWING CODES: A. CURRENT INTERNATIONAL BUILDING CODE. B. CURRENT INTERNATIONAL MECHANICAL CODE. C. CURRENT INTERNATIONAL ELECTRICAL CODE AS APPLICABLE. D. CURRENT NFPA LIFE SAFETY CODES. E. APPLICABLE CITY/STATE PLUMBING CODES.
- F. CURRENT STATE FIRE CODES. G. COMPLIANCE WITH AMERICAN WITH DISABILITIES ACT (ADA).


OWNER SHALL BE RESPONSIBLE FOR OBTAINING ALL APPLICABLE BUILDING PERMITS. THE PERMIT FEES AND THE COSTS OF PROCURING SAME SHALL BE BORNE ENTIRELY BY OWNER. THE PROJECT'S GENERAL CONTRACTOR (G.C.) WILL COORDINATE, SCHEDULE AND PAY FOR ALL REQUIRED SUBCONTRACTOR PERMITS & INSPECTIONS.

- THE G.C. SHALL VERIFY ALL EXISTING CONDITIONS AND DETERMINE THEIR EFFECT ON THE DESIGN PROPOSAL AS SHOWN HEREIN. CARE SHALL BE TAKE TO AVOID ANY INTERRUPTIONS TO THE NORMAL BUSINESS ACTIVITIES OF THE EXISTING TENANTS TO THE ADJACENT
- FINISHES OF FLOORS AND CEILINGS SHALL HAVE A FLAME SPREAD RATING OF 26-75 OR LESS AND A SMOKE DEVELOPED RATING OF 0-450 PER NFPA 101. G.C. TO SUBMIT CONFIRMATION INFORMATION ON ALL FLAME SPREAD RATINGS AS REQUIRED.

- THE G.C. SHALL BE RESPONSIBLE FOR THE REVIEW, COORDINATION, AND INSTALLATION OF REQUIRED LIFE SAFETY EQUIPMENT INCLUDING, BUT NOT LIMITED TO EXIT SIGNS, EMERGENCY LIGHTS, AND FIRE EXTINGUISHER CABINETS (FIRE EXTINGUISHERS). ADDITIONALLY, EGRESS PATHS SHALL BE REVIEWED WITH APPROPRIATE FIRE DEPARTMENT PERSONNEL AND SHALL BE COORDINATED WITH FURNITURE & PARTITIONS.
- 8. WORKMANSHIP STANDARDS:
- ALL WORK SHALL BE PERFORMED IN A SAFE AND EXPEDITIOUS MANNER USING THE RECOMMENDED TOOLS IN ACCORDANCE WITH THE STANDARDS AND PRACTICES OF THE APPROPRIATE TRADE. THE BUILDING SITE SHALL BE KEPT CLEAN AND FREE OF DEBRIS AT ALL TIMES. CARE SHALL BE TAKEN TO PREVENT TRASH FROM BEING BLOWN ONTO AND ACCUMULATING ON ADJACENT PROPERTIES AND PUBLIC STREETS.
- THE PROJECT G.C. SHALL ARRANGE AND EXECUTE ALL FINAL INSPECTIONS AND PROCURE A CERTIFICATE FOR OCCUPANCY. ADDITIONALLY, THE G.C. SHALL DELIVER INTERIORS FREE OF MARKS, FINGERPRINTS, STAINS, DIRT AND DEBRIS. LIGHT FIXTURES, PLUMBING FIXTURES, EQUIPMENT, GLASS AND HARDWARE WILL BE CLEAN AND "DUST FREE" BY COMMERCIAL STANDARDS. SITE SHALL BE CLEANED AND FREE OF EXTRANEOUS DEBRIS PRIOR TO ACCEPTANCE. G.C. SHALL RESTORE LAWNS AND PATCH ANY PAVING DAMAGED DURING
- 10. EGRESS DOORS SHALL BE OPERABLE FROM THE DIRECTION OF EXIT TRAVEL WITHOUT THE USE OF A KEY OR SPECIAL KNOWLEDGE OR EFFORT.
- WHEREVER WOOD IS CALLED FOR IN THE DRAWINGS.
- 12. ALL CONTRACTORS ARE REQUIRED TO REVIEW ALL DRAWINGS REGARDLESS OF DISCIPLINE AND SHALL BE HELD RESPONSIBLE FOR COORDINATING THEIR WORK WITH ALL OTHER
- 13. IF ANY CONFLICTS ARE FOUND ON THE DRAWINGS OR BETWEEN THE DRAWINGS AND SPECIFICATIONS, THE CONTRACTOR IS RESPONSIBLE FOR PRICING THE MOST EXPENSIVE OF THE CONFLICTING PRODUCTS/ASSEMBLY/SYSTEM.
- 14. THE G.C. IS RESPONSIBLE FOR ANY TEMPORARY SHORING REQUIRED TO PERFORM WORK. ALL SHORING SHALL BE ENGINEERED BY AN ENGINEER LICENSED IN THE STATE WHERE THE WORK IS BEING PERFORMED. SUBMIT ENGINEER SIGNED/SEALED DRAWINGS FOR REVIEW.

MAPS

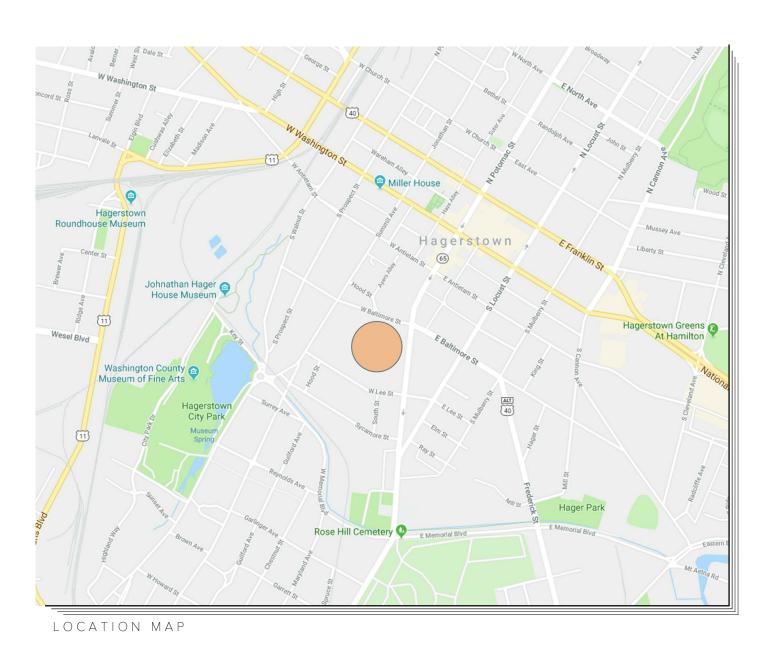

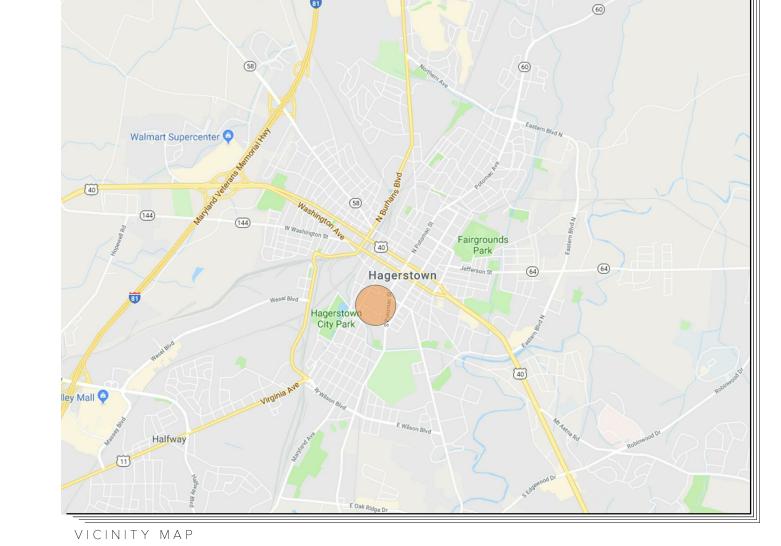

ABBREVIATIONS

A/C ACT AWP AFF ALT ALUM ANOD APROX ASPH BLDG BRL CAB CJ CL CLG CLR CMU CNT COL CONC CPT CT CW DF DIA DIM DIV DN DS DWG	AIR CONDITIONING ACOUSTICAL CEILING TILE ACOUSTICAL WALL PANEL ABOVE FINISHED FLOOR ALTERNATE ALUMINUM ANODIZED FINISH APPROXIMATE ASPHALT BUILDING BUILDING RESTRICTION LINE CABINET CONTROL JOINT CENTER LINE CEILING CLEAR CONCRETE MASONRY UNIT CONTINUOUS COLUMN CONCRETE CARPET CERAMIC TILE COLD WATER DRINKING FOUNTAIN DIAMETER DIMENSION DIVISION DOWN DOWNSPOUT DRAWING	ELEV EMER EQ EQPT EX EXP EXT FD FE FEC FIN FLR FT GA GALV GC GL G.S.F. GWB H/C HC HM HORZ HR HT HVAC	ELEVATION EMERGENCY EQUAL EQUIPMENT EXISTING EXPOSED EXTERIOR FLOOR DRAIN FIRE EXTINGUISHER FIRE EXTINGUISHER CABINET FINISH (ED) FLOOR FEET/FOOT FOOTING FURRING GAUGE GALVANIZED GENERAL CONTRACTOR GLAZING GROSS SQUARE FEET GYPSUM WALLBOARD HANDICAP(PED) HOLLOW CORE HOLLOW METAL HORIZONTAL HOUR HEIGHT HEATING, VENTING & AIR CONDITIONING HOT WATER	INT JAN JT KIT LAM LAV MAX MECH MTL MFR MH MIN MISC MO MULL N/A N NIC NO. NTS PERF PNL PNT PREFAB PSF PSI PT PWD	INTERIOR JANITOR'S CLOSET JOINT KITCHEN LAMINATE LAVATORY MAXIMUM MECHANICAL METAL MANUFACTURER MANHOLE MINIMUM MISCELLANEOUS MASONRY OPENING MULLION NOT APPLICABLE NORTH NOT IN CONTRACT NUMBER NOT TO SCALE PERFORATED PANEL PAINT PREFABRICATED POUNDS PER SQUARE FOOT POUNDS PER SQUARE INCH PRESSURE TREATED PLYWOOD	REV RM RO RTG S SC SCH SF SHT SIM SPEC SS ST TEL TEMP TV TYP UON VERT VCT VWC W/ W/O W WC WD	REVISION ROOM ROUGH OPENING RATING SOUTH SOLID CORE SCHEDULE SQUARE FOOT SHEET SIMILAR SPECIFICATIONS STAINLESS STEEL STREET STEEL TONGUE & GROOVE TELEPHONE TEMPORARY TELEVISION TYPICAL UNLESS OTHERWISE NOTED VERTICAL VINYL TILE VINYL WALL COVERING WITH WITHOUT WEST WATER CLOSET WOOD
DWG E EJ	DRAWING EAST EXPANSION JOINT	HW IN INS	HOT WATER INCH INSULATION	RAD RD	PLYWOOD RADIUS ROAD	WD WIN WP	WOOD WINDOW WATERPROOFING

ARCHITECTURE **ROOF PLAN** A1.2 DETAILS A1.3 DETAILS

May 29, 2019

PHASE:

CONSTRUCTION DOCUMENTS

SUBMITTALS / REVISIONS

I CERTIFY THAT THESE DOCUMENTS WERE PREPARED OR APPROVED BY ME, AND THAT I AM A DULY LICENSED ARCHITECT UNDER THE STATE OF MARYLAND



I I W BALTIMORE ST. HAGERSTOWN, MD 21740

REPLACEMENT

PROJECT OWNER:


HAGERSTOWN HOUSING AUTHORITY 35 W BALTIMORE ST HAGERSTOWN MD, 21740

ARCHITECTS

POTOMAC TOWERS - ROOF

PROJECT ARCHITECT:

MSB ARCHITECTS 1165 IMPERIAL DRIVE SUITE 208 HAGERSTOWN, MD 21740

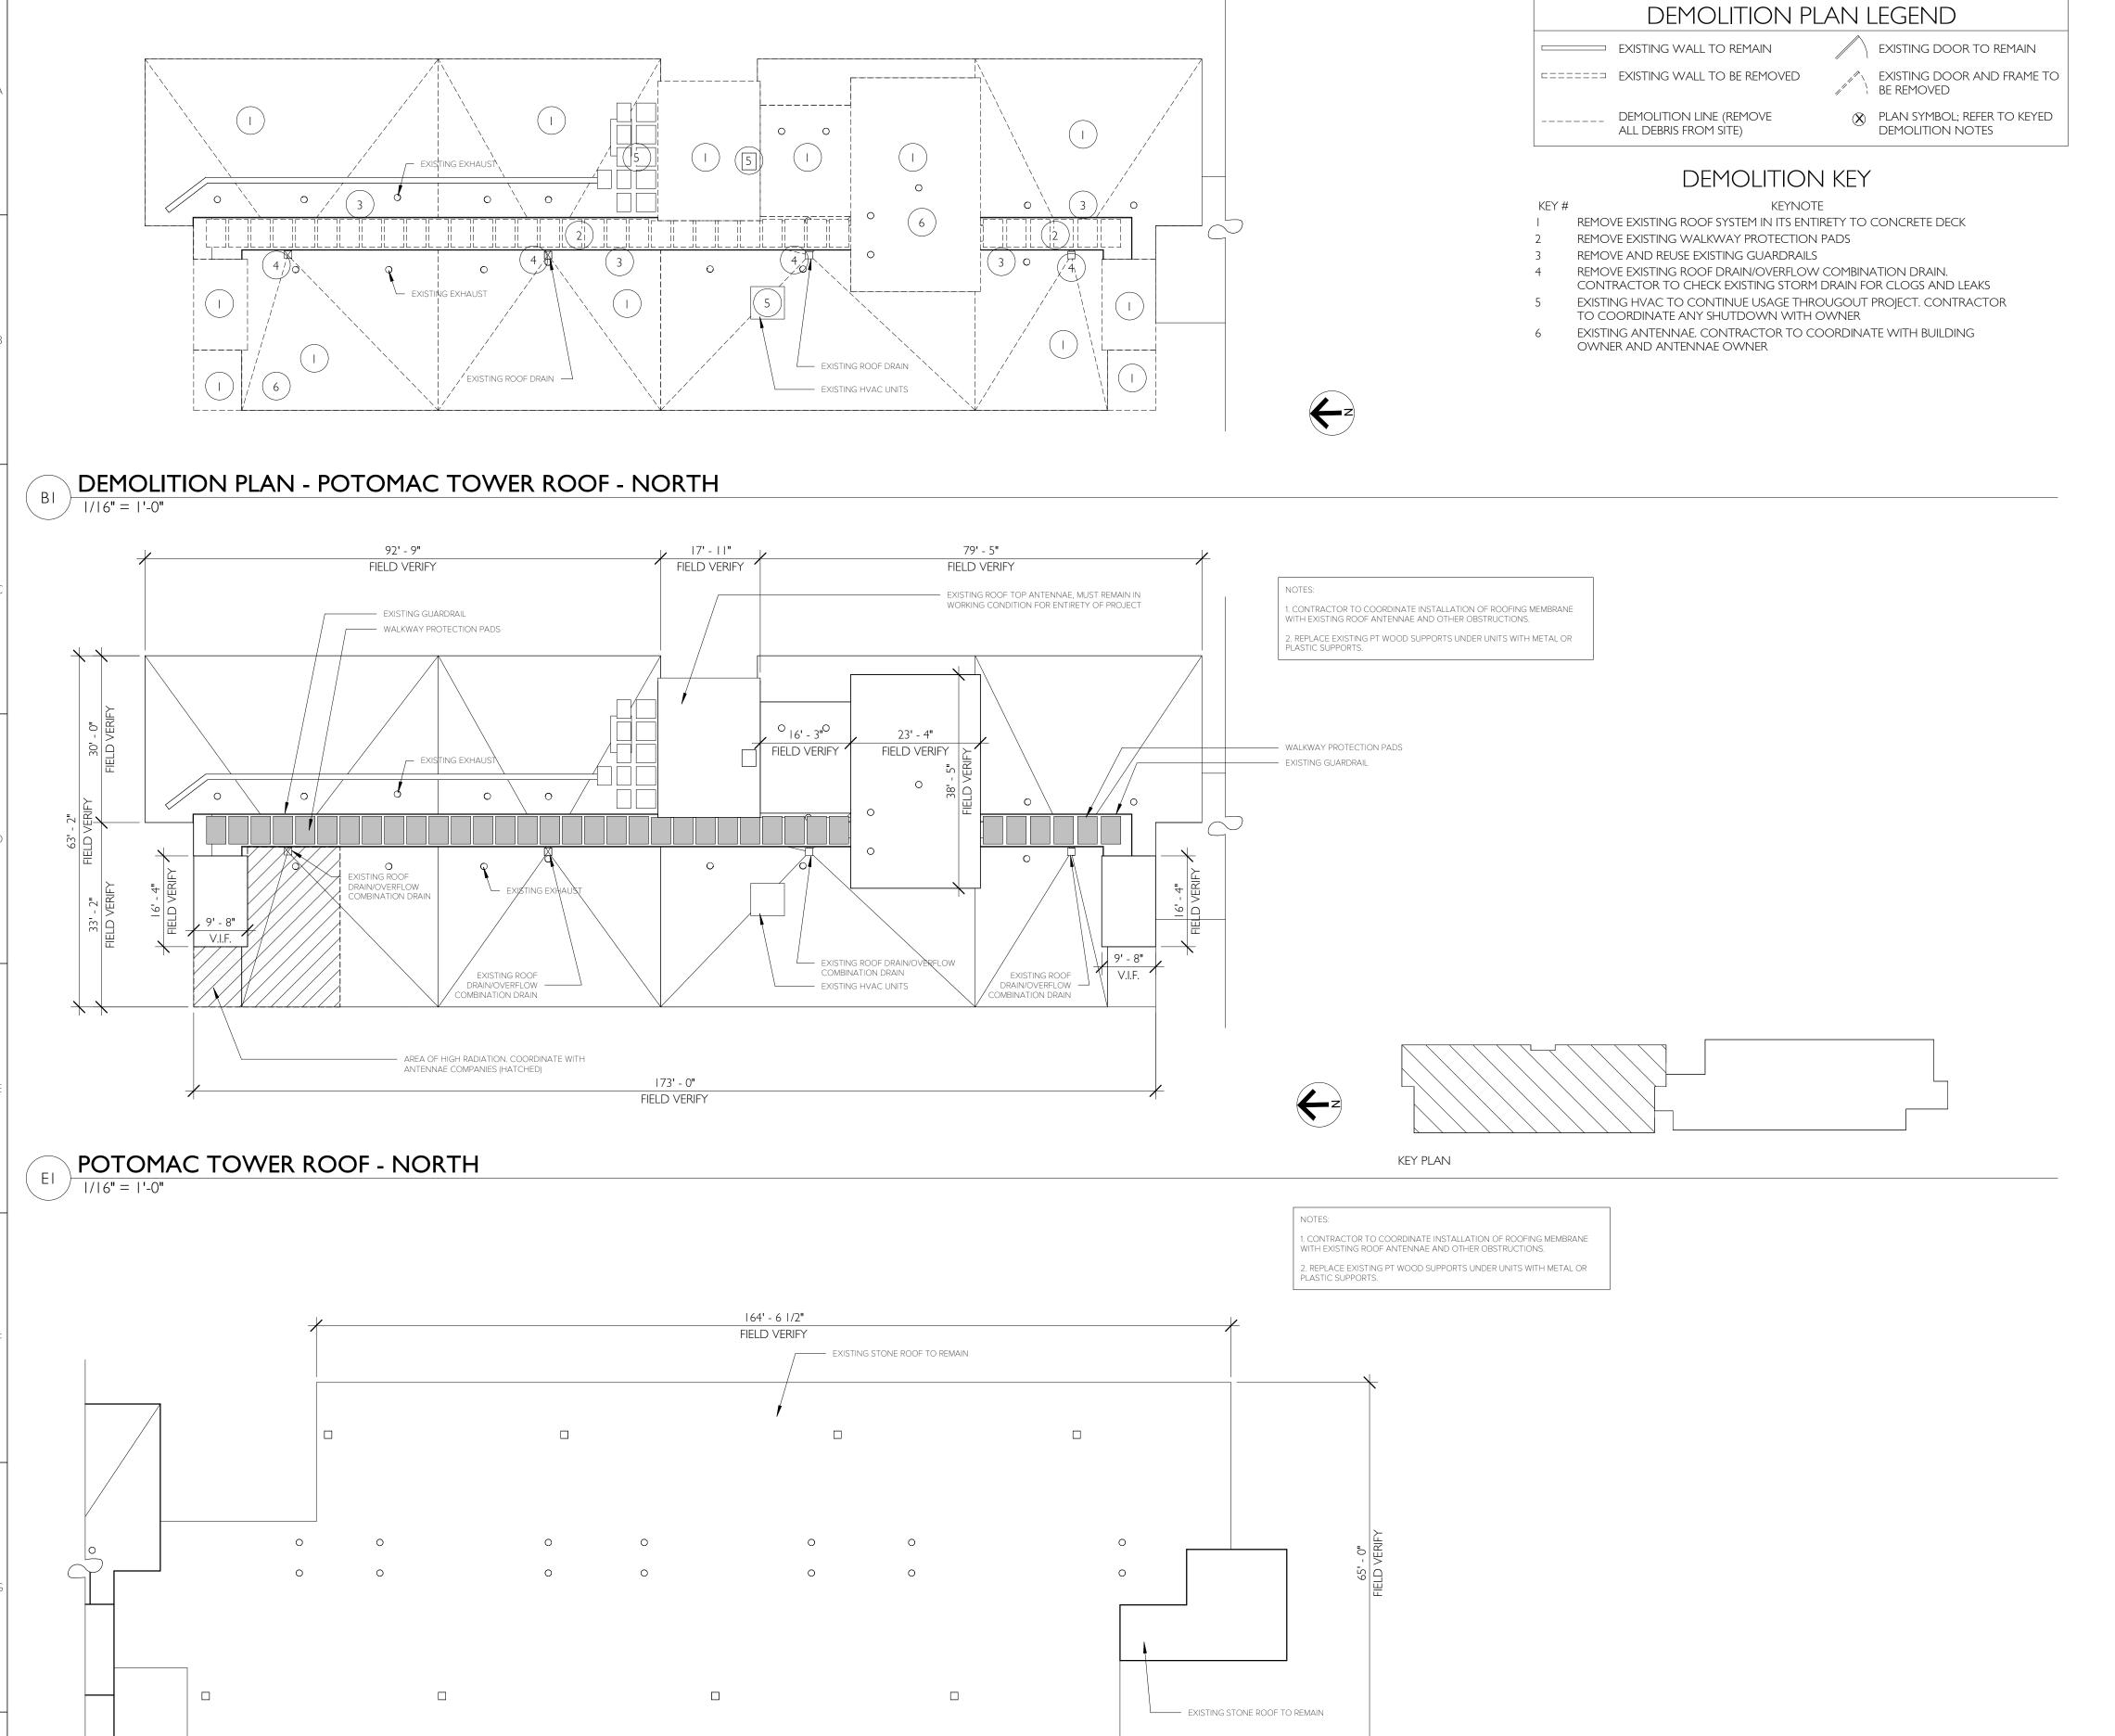

GENERAL DEMOLITION NOTES

- I DO NOT SCALE DRAWINGS. CHECK AND VERIFY ALL EXISTING CONDITIONS AND DIMENSIONS AT SITE BEFORE PROCEEDING WITH WORK, EXISTING DIMENSIONS NOTED ON DRAWING ARE FROM OWNER PROVIDED DOCUMENTS AND HAVE NOT BEEN FIELD
- 2 ALL CODED DEMOLITION NOTES ARE NOT REFERENCED ON ALL PLAN DRAWINGS. CODED DEMOLITION NOTES MAY BE GROUPED FOR CLARITY BUT IN NO WAY SHOULD BE CONSTRUED AS LIMITING THE SCOPE OF WORK TO PARTICULAR GROUPING. ALL NOTES SHOULD BE REVIEWED TO ESTABLISH THE OVERALL SCOPE OF WORK.
- 3 ANY CONFLICT OR DISCREPANCY BETWEEN INFORMATION ON DRAWINGS AND ACTUAL FIELD 'AS-BUILT' CONDITIONS SHOULD BE BROUGHT TO THE ARCHITECT'S ATTENTION FOR RESOLUTION PRIOR TO COMMENCING WITH WORK.
- 4 DEMOLITION DRAWINGS ARE INTENDED TO INDICATE SCOPE AND GENERAL INTENT OF THE GENERAL DEMOLITION WORK REQUIRED, BUT DO NOT IN ANY WAY LIMIT THE AMOUNT OF DEMOLITION ONLY TO THE ITEMS SHOWN. DEMOLITION WORK INCLUDES REMOVAL OF ALL THAT WILL INTERFERE WITH THE CONSTRUCTION AND
- PATCHING AS REQUIRED AT ALL DISTURBED AREAS WITHOUT LIMITATION. 5 SEE ARCHITECTURAL DRAWINGS TO DETERMINE EXTENT OF DEMOLITION REQUIRED TO EXISTING PARTITONS.
- 6 PATCHING REQUIRED BY DEMOLITION WORK SHALL MATCH EXISTING ADJACENT MATERIALS.
- 7 DEMOLISH ITEM COMPLETE WITH ALL ADHESIVES, FASTENERS, AND ACCESSORIES.
- 8 SALVAGE EXISTING FINISH MATERIALS WHEREVER POSSIBLE FOR PATCHING EXISTING FINISHES. COORDINATE EXTENT OF THE FINISH WORK REQUIRED WITH CONSTRUCTION DOCUMENTS.
- 9 SALVAGE EQUIPMENT OR OTHER ITEMS AS NOTED. SALVAGED EQUIPMENT SHALL BE REUSED OR RETURNED TO OWNER AS DIRECTED.
- 10 CAREFULLY REMOVE ITEMS TO BE REUSED AND STORE IN AN AREA AS DIRECTED BY THE
- 11 CONTRACTOR TO PROVIDE ALL NECESSARY SHORING REQUIRED DURING DEMOLITION. IF SHORING IS REQUIRED AS PART OF MEANS AND METHODS DURING CONSTRUCTION TO COMPLETE THE WORK, THE CONTRACTOR IS REQUIRED TO OBTAIN SIGNED & SEALED DRAWINGS BY A LICENSED ENGINEER IN THE STATE OF THE PROJECT

GENERAL ROOF NOTES

- THE REPLACEMENT OF THE ROOF SHALL BE CONDUCTED IN SUCH A MANNER AS TO PROTECT THE EXISTING BUILDING AND ALL OF ITS CONTENTS IN THEIR ENTIRETY. THE CONTRACTOR SHALL BE RESPONSIBLE FOR ANY DAMAGE CAUSED DURING THE PERFORMANCE OF THEIR CONTRACTED WORK
- 2 DIMENSIONS, DETAILS, EQUIPMENT SIZE AND LOCATION SHOWN ON THESE ROOF PLAN AND ROOF DETAILS ARE FOR INFORMATION AND REFERENCE ONLY. EXACT SIZE, LOCATION, TYPE OF MATERIAL AND TYPE OF CONSTRUCTION ARE THE RESPONSIBILITY OF THE SUBCONTRACTOR TO CONFIRM AND GENERAL CONTRACTOR TO COORDINATE.
- 3 MINIMUM SLOPE ALLOWABLE ON THE ROOF SHALL BE NO LESS THAN 1/4" PER FOOT. CRICKET THE UP SLOPE SIDE OF ALL SQUARE CURBS AND PROJECTIONS OVER 20" IN WIDTH.
- 4 ALL NEW CRICKET AND TAPERED INSULATION SHALL BE INSTALLED WITH A FINISH 1/4" PER
- FOOT MIN. SLOPE. CRICKET THE UP SLOPE SIDE OF ALL SQUARE CURBS AND PROJECTIONS. 5 ALL PIPING/CONDUITS/ETC. SHALL BE A MIN. 10" ABOVE ROOF SURFACE. PROVIDE PORTABLE PIPE HANGERS WITH PROTECTION PADS. MEP CONTRACTOR SHALL PROVIDE SUPPORTS FOR NEW
- 6 PROVIDE 22ga. STAINLESS STEEL, 2D FINISH, TREATED WOOD CURB AND BOX HOOD AT ALL GAS LINE AND WATER LINE ROOF PENETRAIONS.
- 7 ISOLATE ALL HEAT PIPES/FLUES AS RECOMMENDED & OUTLINED IN THE NRCA MANUAL ISOLATED STACK FLASHING.
- 8 PROVIDE WALKWAY PROTECTION PADS AROUND ALL ROOF HATCHES, A/C UNITS, AND AT ALL ROOF TOP ACCESS DOORS AND LADDERS (TOP & BOTTOM)
- 9 GENERAL CONTRACTOR TO ENSURE ALL ROOFTOP PENETRATIONS (EQUIP, SOIL STACKS, ETC.) ARE INSTALLED MIN. 2'-0" FROM OTHER DECK PENETRATIONS, RISE WALLS, AND ROOF EDGE.
- 10 THROUGH WALL BASE FLASHING MIN. HEIGHT 10" AND MAX. HEIGHT 20" FROM FINISH DECK. DO NOT STEP THROUGH WALL FLASHING CLOSER THAN 5'-0" FROM CORNERS.
- 11 UPON SUSTANTIAL COMPLETION THE GENERAL CONTRACTOR SHALL EXAMINE AND ENSURE DRAIN LLINES, GUTTERS AND DOWNSPOUTS ARE FREE OF DEBRIS AND BLOCKAGE, FLUSH WITH WATER TO ENSURE THAT DRAINS FLOW FREELY, WHERE APPLICABLE.
- 12 FIELD VERIFY SIZE AND LOCATION OF ALL EXISTING MECHANICAL UNITS, ROOF CURBS, ROOF DRAINS, SCUPPERS, SKYLIGHTS AS WELL AS ANY AND ALL OTHER PENETRATIONS ON ROOF ACCESSORIES AND INSTALL NEW ROOF AS REQUIRED TO ACCOMMODATE ACCESSORIES AND CREATE A WATER TIGHT SEAL OVER ENTIRE ROOF.
- 13 COORDINATION OF EXISTING BUILDING UTILITIES IS THE RESPONSIBILITY OF THE CONTRACTOR PRIOR TO COMMENCEMENT OF THE ROOFING REPLACEMENT. IF ANY SERVICE TO THE EXISTING BUILDING IS REQUIRED TO BE TURNED OFF BY THE CONTRACTOR, THE SHUT-OFF MUST BE SCHEDULED IN ADAVANCE WITH THE HAGERSTOWN HOUSING AUTHORITY MAINTENANCE DEPARTMENT AND ADMINISTRATION.

GENERAL ARCHITECTURAL NOTES

- I CONSULTANTS SHEETS ARE SUPPLEMENTAL TO THE ARCHITECTURAL SHEETS. IT IS THE RESPONSIBILITY OF THE GENERAL CONTRACTOR TO CROSS CHECK WITH THE ARCHITECTURAL SHEETS PRIOR TO THE ORDERING/INSTALLATION OF ANY OF THE MECHANICAL, PLUMBING, ELECTRICAL, STRUCTURAL AND SITE WORK. ANY DISCREPANCIES BETWEEN THE ARCHITECTURAL AND THE CONSULTING ENGINEERS SHEET SHALL BE BROUGHT TO THE ARCHITECTS ATTENTION FOR IMMEDIATE CLARIFICATION.
- 2 WRITTEN DIMENSIONS ALWAYS TAKE PRECEDENCE OVER SCALE ON THE CONSTRUCTION DOCUMENTS. DO NOT SCALE.
- 3 THE GENERAL CONTRACTOR SHALL PERSONALLY SUPERVISE AND DIRECT ALL WORK. THE GENERAL CONTRACTOR IS RESPONSIBLE FOR ALL CONSTRUCTION AND/OR INSTALLATION METHODS, MEANS, TECHNIQUES, SEQUENCES, PROCEDURES AND COORDINATION OF ALL PORTIONS OF THE REQUIRED WORK.
- 4 FOR CUTTING AND PATCHING WHERE EXISTING CONDITION ARE TO BE CUT OR DISTURBED TO PERMIT INSTALLATION OF NEW WORK, PATCH ANY DISTURBED CONSTRUCTION TO MATCH THE ORIGINAL CONSTRUCTION AND FINISH.
- 5 ANY CONFLICT OR DISCREPANCY BETWEEN INFORMATION ON DRAWINGS AND ACTUAL FIELD CONDITIONS SHOULD BE BROUGHT TO ARCHITECT'S ATTENTION FOR RESOLUTION PRIOR TO COMMENCING WITH WORK.



1165 Imperial Drive, Suite 208 Phone: 301.791.7935 Hagerstown, MD 21740

POTOMAC TOWERS - ROOF REPLACEMENT

11 W BALTIMORE ST. HAGERSTOWN, MD 21740

I CERTIFY THAT THESE DOCUMENTS WERE PREPARED OR APPROVED BY ME, AND THAT I AM A DULY LICENSED ARCHITECT UNDER THE



May 29, 2019 EXPIRATION DATE: 8/24/2020 LICENSE NUMBER: 14742

PHASE:

CONSTRUCTION DOCUMENTS

SUBMITTALS / REVISIONS

MSB DRAWN BY: DATE: May 29, 2019 SCALE: AS NOTED

DRAWING NAME:

ROOF PLAN


SHEET:

POTOMAC TOWER ROOF - SOUTH


KEY PLAN

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ARCHITECTS

1165 Imperial Drive, Suite 208 Phone: 301.791.7935 Hagerstown, MD 21740
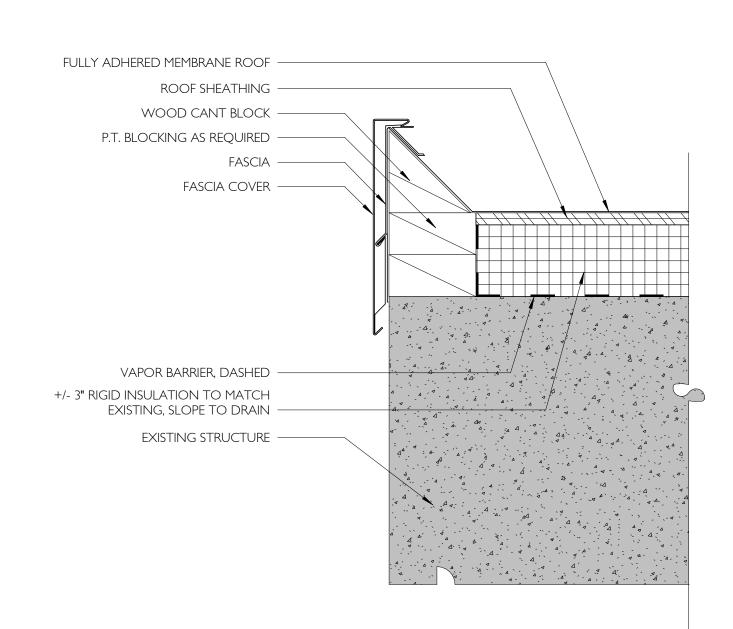
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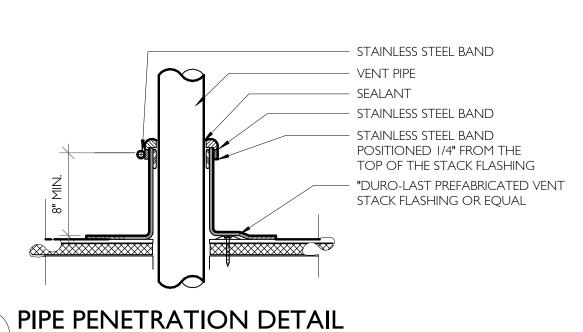
MSB DRAWN BY: DATE: May 29, 2019 SCALE: AS NOTED


DRAWING NAME:

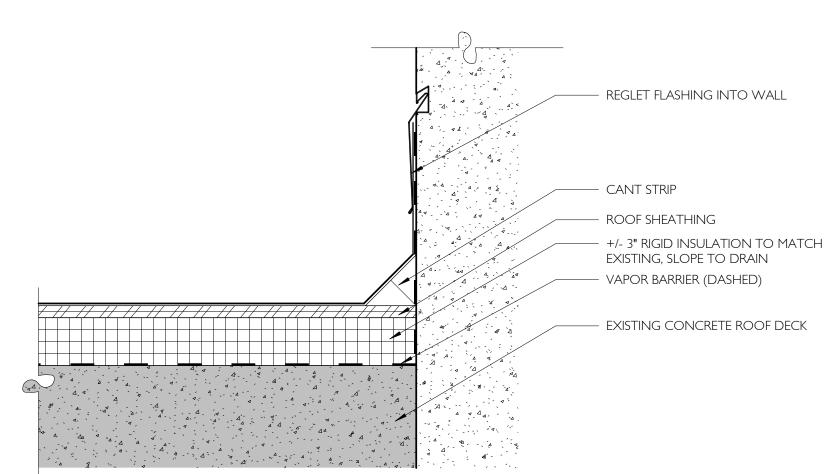DETAILS


SHEET:

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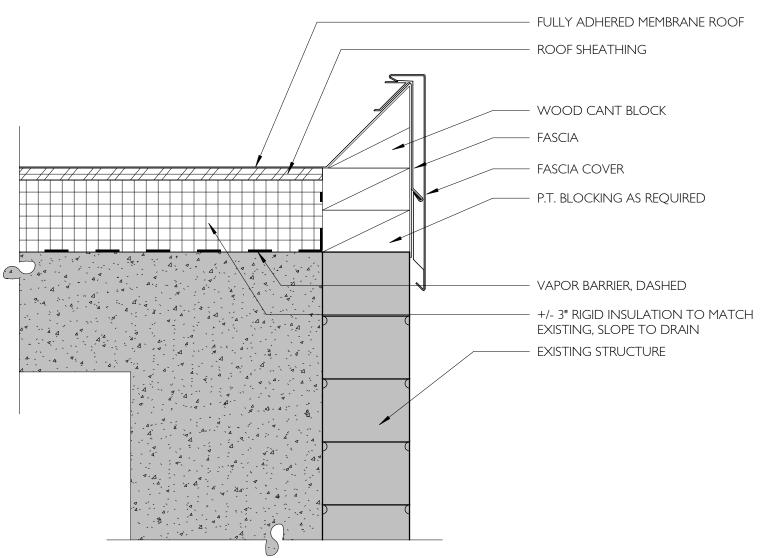


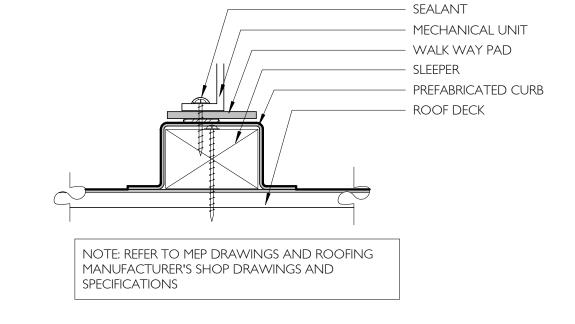


EQUIPMENT CURB DETAIL




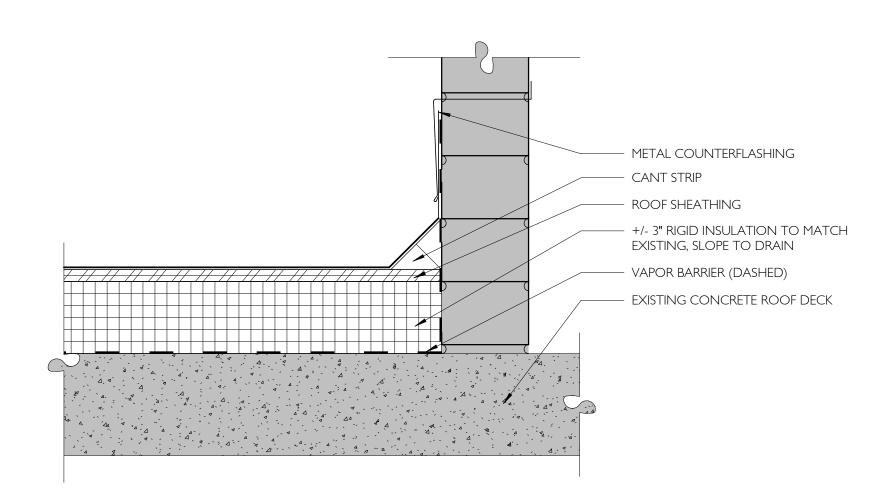




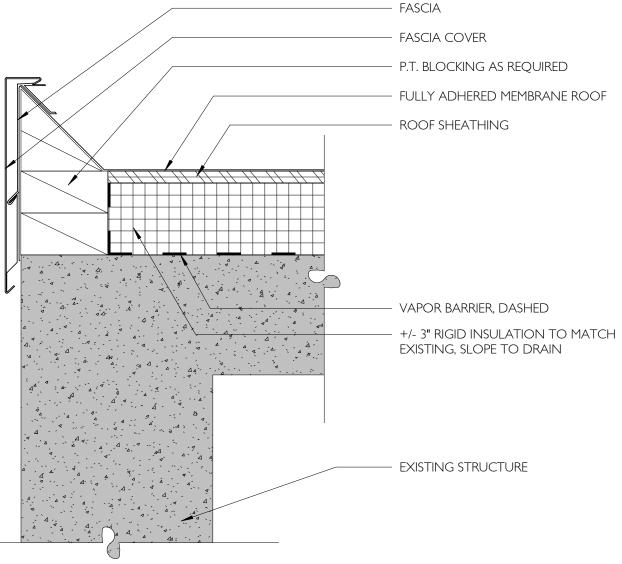


ROOF CANT
3" = | '-0"

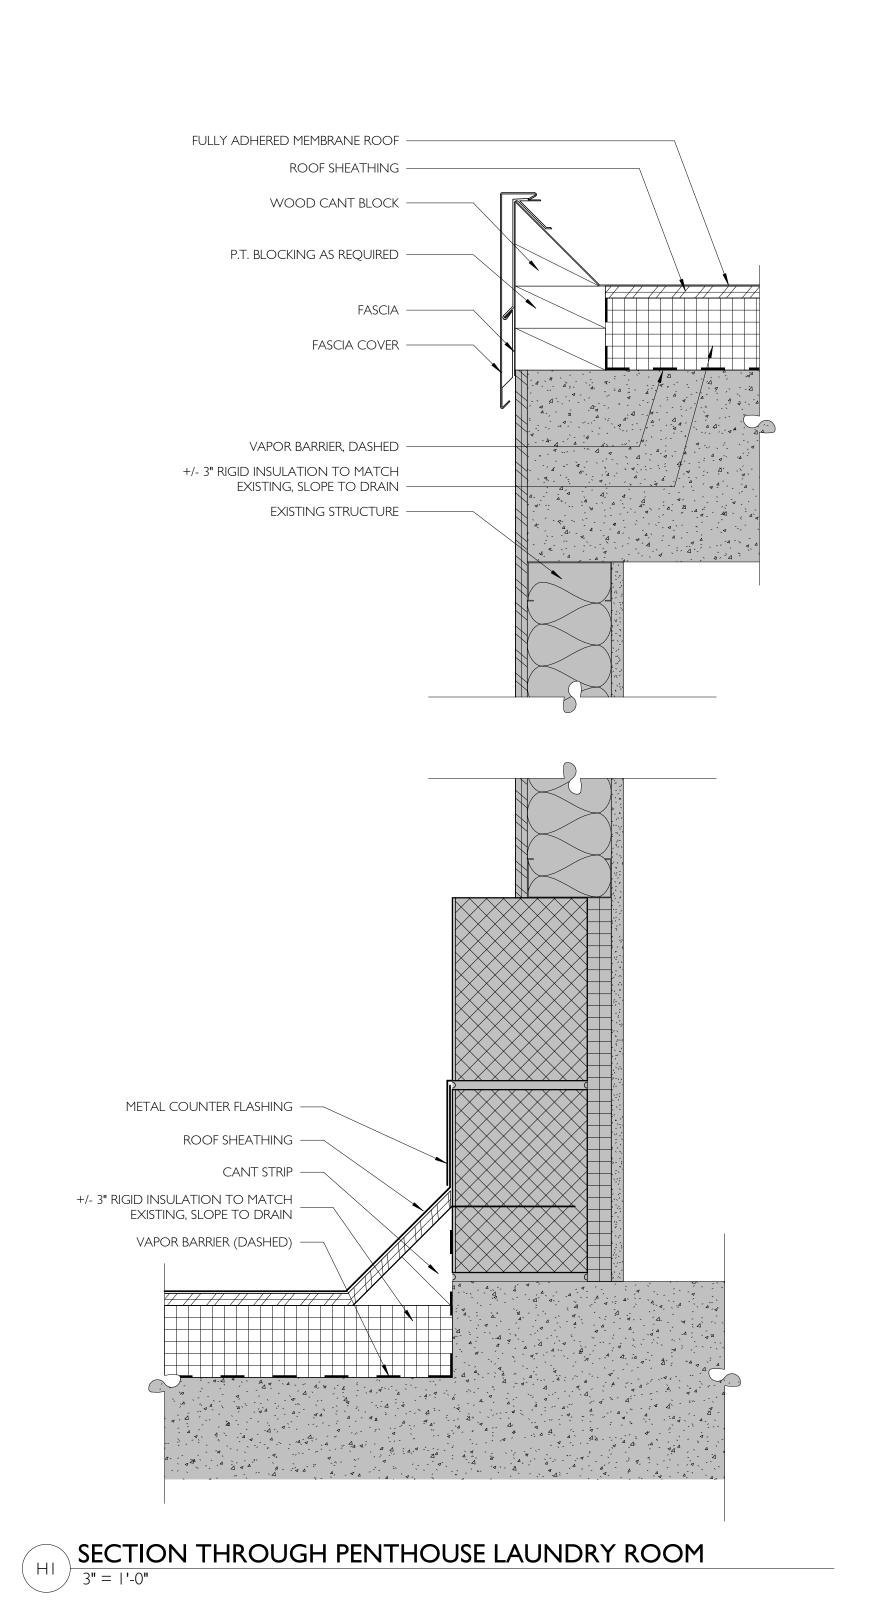

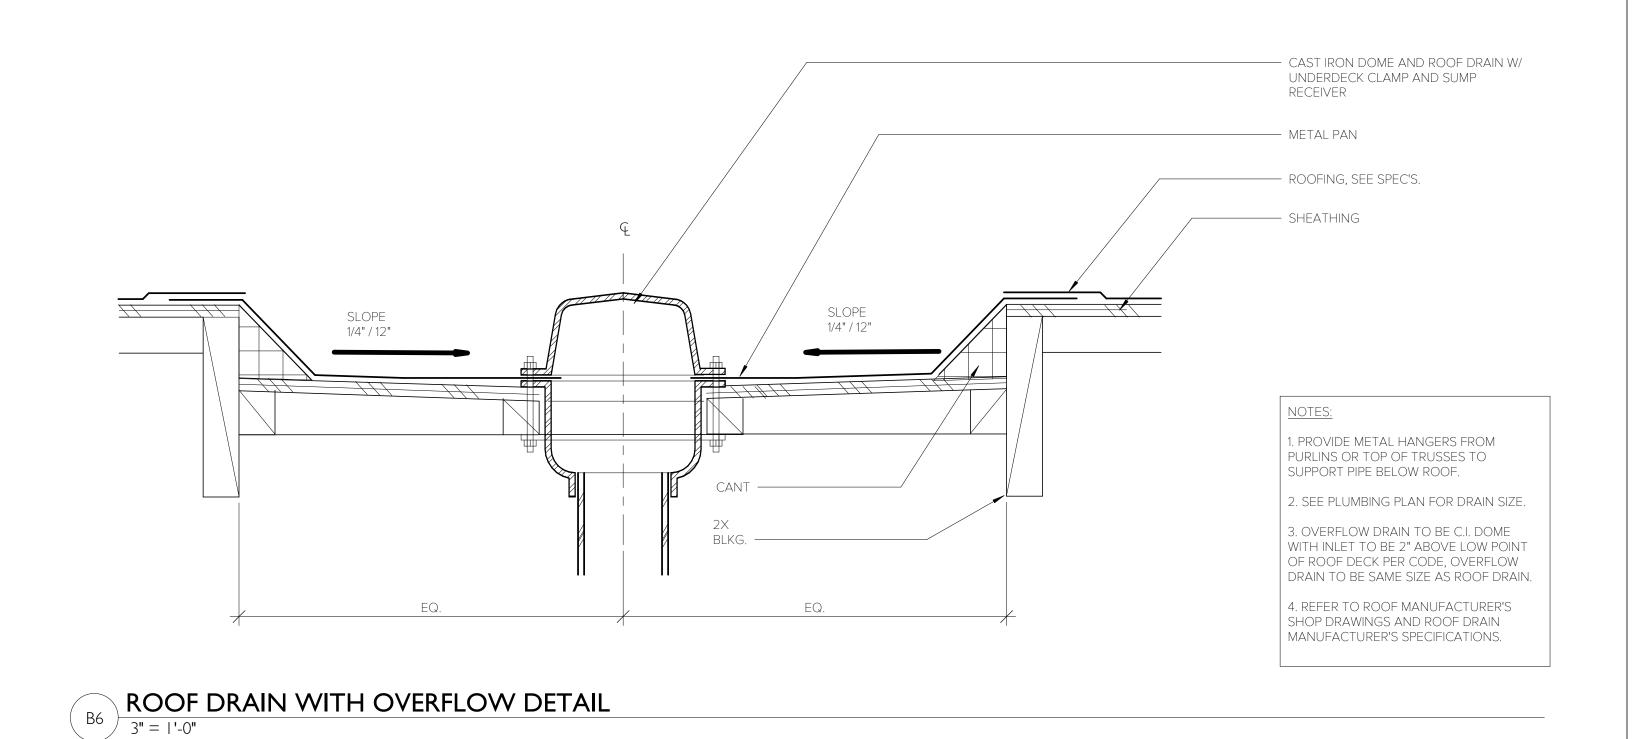

- FULLY ADHERED MEMBRANE ROOF - ROOF SHEATHING - WOOD CANT BLOCK - FASCIA — FASCIA COVER — P.T. BLOCKING AS REQUIRED – VAPOR BARRIER, DASHED - +/- 3" RIGID INSULATION TO MATCH EXISTING, SLOPE TO DRAIN - EXISTING STRUCTURE

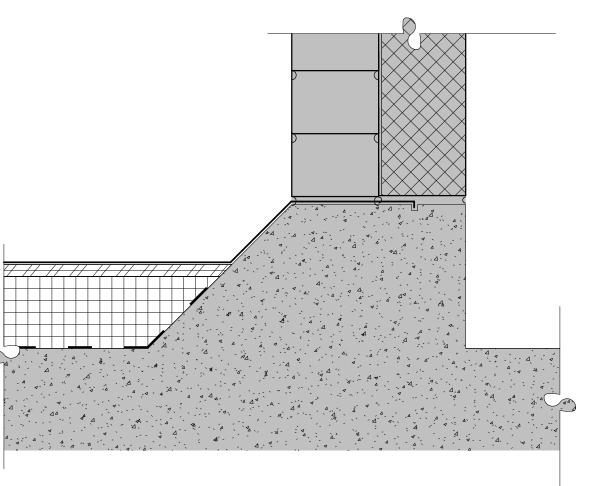

H6 STAIR TOWER DETAIL
3" = 1'-0"

ARCHITECTS 1165 Imperial Drive, Suite 208 Hagerstown, MD 21740 Phone: 301.791.7935

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A1.3

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